
YOLO BYPASS WILDLIFE AREA HABITAT AND DRAINAGE IMPROVEMENTS PROJECT


METROPOLITAN WATER DISTRICT OF SOUTHERN CALIFORNIA

PREPARED BY:

CBEC ECO ENGINEERING

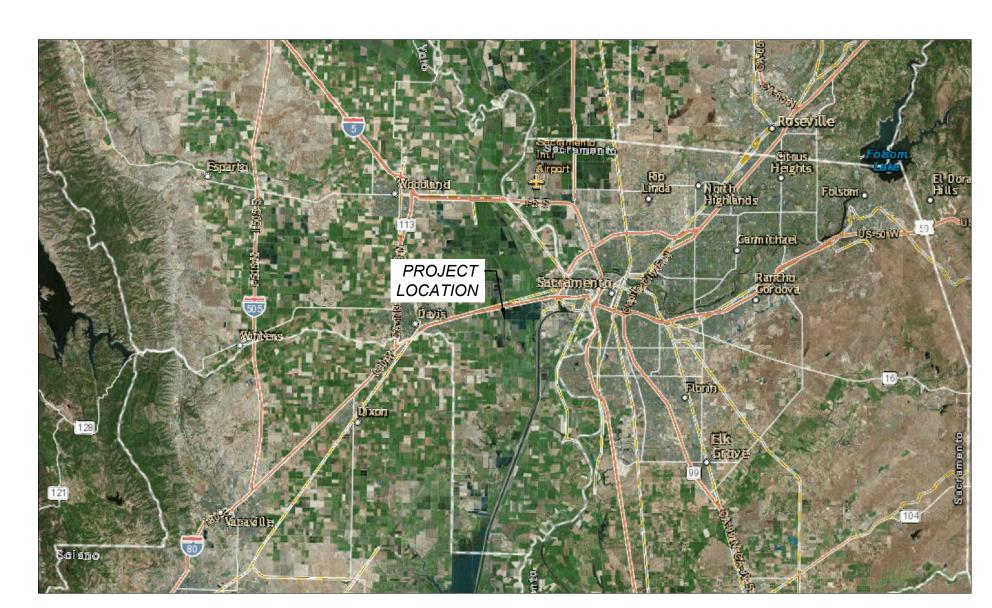

PROJECT LOCATION MAP

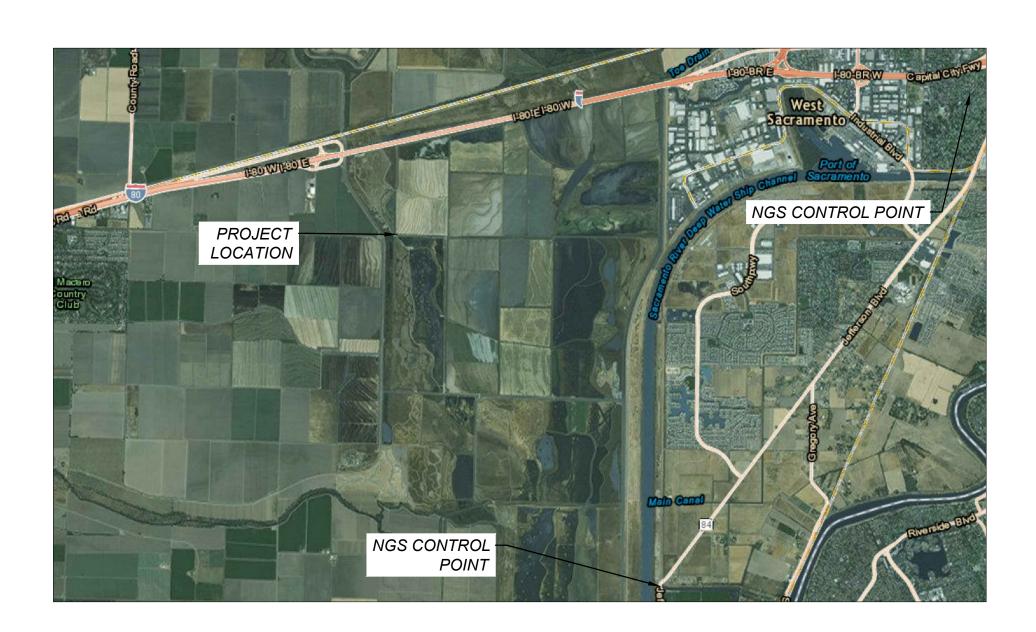

Sheet List Table			
Sheet Number	Sheet Title		
G-01	COVER		
G-02	SHEET LAYOUT PLAN		
G-03	SITE ACCESS AND STAGING PLAN		
01	SUB-PROJECT 1 - RICE CORNER GRADING PLAN		
02	SUB-PROJECT 1 - RICE CORNER BRIDGE SECTION		
03	SUB-PROJECT 1 - I-80 DITCH GRADING STA 0+00 TO 20+50		
04	SUB-PROJECT 1 - I-80 DITCH GRADING STA 20+50 TO 44+25		
05	SUB-PROJECT 1 - CULVERT IMPROVEMENTS PLAN		
06	SUB-PROJECT 1 - CULVERT IMPROVEMENTS SECTION		
07	SUB-PROJECT 3 - THE Y IMPROVEMENT PLAN		
08	SUB-PROJECT 3 - THE Y GRADING SECTIONS		
09	SUB-PROJECT 3 - N-S DITCH GRADING STA 0+00 TO 11+85		
10	SUB-PROJECT 3 - N-S DITCH GRADING STA 11+85 TO 23+35		
11	SUB-PROJECT 3 - N-S DITCH GRADING STA 23+35 TO 27+97		
12	SUB-PROJECT 3 - CULVERT IMPROVEMENT PLAN		
13	SUB-PROJECT 3 - GRADING AND CULVERT SECTIONS		
14	SUB-PROJECT 5 - GRADING PLAN		

EARTHWORK SUMMARY TABLE					
SUB-PROJECT NO.	SUB-PROJECT NAME	CUT (BCY)	FILL (CCY)	NET (BCY)	
1	DRAINAGE IMPROVEMENTS AT RICE CORNER	3019	4812	3397 <fill></fill>	
3	DRAINAGE IMPROVEMENTS AT THE Y	5104	1477	3135 <cut></cut>	
5	PARKER POND	1141	659	262 <cut></cut>	
	TOTALS	9264	6948	0 <balanced></balanced>	

15	SUB-PROJECT 5 - GRADING SECTIONS		
16	TYPICAL DETAILS 1		
17	TYPICAL DETAILS 2		
18	SUB-PROJECT 1 - BRIDGE PLANS		
19	SUB-PROJECT 1 - FOUNDATION PLAN		
20	SUB-PROJECT 1 - BRIDGE DETAILS 1		
21	SUB-PROJECT 1 - BRIDGE DETAILS 2		
22	SUB-PROJECT 1 - BRIDGE DETAILS 3		
23	SUB-PROJECT 3 - OVERALL BRIDGE PLAN		
24	SUB-PROJECT 3 - BRIDGE PLAN		
25	SUB-PROJECT 3 - FOUNDATION PLAN		
26	SUB-PROJECT 3 - BRIDGE DETAILS 1		
27	SUB-PROJECT 3 - BRIDGE DETAILS 2		
28	SUB-PROJECT 3 - BRIDGE DETAILS 3		
29	SUB-PROJECT 3 - BRIDGE DETAILS 4		
30	BRIDGE SPECIFICATIONS 1		
31	BRIDGE SPECIFICATIONS 2		
32	OVERALL ELECTRICAL PLAN		
33	ELECTRICAL SITE PLAN PUMP STATION/POLELINE RELOCATION		
34	OVERHEAD POLE LINE CONSTRUCTION		
35	OVERHEAD POLE LINE CONSTRUCTIONELECTRICAL SITE PLAN		
36	NEW PUMP STATION DETAILS		

1. EARTHWORK VALUES ACCOUNT FOR A 25% SHRINKAGE FACTOR (I.E.,

2. FILL VALUES DO NOT INCLUDE THE VOLUME OF CRUSHED AGGREGATE

BASE FOR ROAD PAVING, ESTIMATED AT 120 CY

1" = 100'

PEN TABLE: ----

BRDR DATE: 01/29/2009 | | | | |



ISSUE DESCRIPTION 100% DESIGN FOR DRAWING APPROVALS SEE ISSUE DATE APRIL 2017 CHECKED

YOLO BYPASS WILDLIFE AREA HABITAT AND DRAINAGE IMPROVEMENTS **COVER**

143939 CBEC PROJECT# 15-1025 SHEET G-01

SFCWA CONTRACT#

PLOT TIME: 1/9/2017 4:47 PM

FILEPATH: C:\USERS\D.TU\DOCUMENTS\PROJECTS 2015\15-1025_YBWA_DESIGN\CAD_DWGS\PRODUCTION

FILE NAME: G-01 - COVER_2011_RR.DWG





